
# McINTYRE FEDERAL BUILDING REDEVELOPMENT

MIXED USE (RETAIL/ OFFICE/ APARTMENTS)

PORTSMOUTH, NH

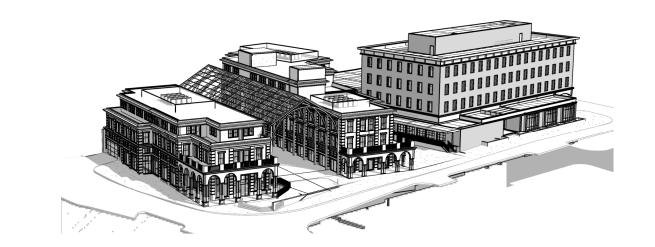

## **OWNER**

## THE KANE COMPANY CITY OF PORTSMOUTH

c/o SoBow Square LLC 210 Commerce Way Portsmouth, NH 03801

Contact: Kimery Poldrack Phone: 603.559.9646

CONSTRUCTION MANAGER

STRUCTURAL ENGINEER

JAL Architecture and Engineering P.C. 1359 Hooksett Road, Suite 1 Hooksett, NH 03106

INTERIOR DESIGNER

**FOOD SERVICE** 

**MECHANICAL** 

**ELECTRICAL** TBD

**PLUMBING** TBD

**FIRE PROTECTION** TBD

#### **PLANNER**

PRINCIPLE GROUP 8 Burney Street Boston, MA 02120 Contact: Russell Preston/ Ariane Rutt

#### CIVIL ENGINEER


Tighe & Bond 177 Corporate Drive Portsmouth, NH 03801 Contact: TBD Phone: 603.433.8818

#### LANDSCAPE ARCHITECT

#### NATIONAL PARK SERVICE - OBTAINING PROPERTY FOR HISTORIC MONUMENT PURPOSES SHEET INDEX

SHEET NO.	SHEET NAME					
SECTION II - PARTS 8 & 9 PRESERVATION AND USE PLANS						
CS-1	COVER SHEET					
CS-2	LEGENDS & SCHEDULES					
D100	BASEMENT FLOOR DEMOLITION PLAN					
D101	FIRST FLOOR DEMOLITION PLAN					
D102	SECOND FLOOR DEMOLITION PLAN					
D103	THIRD FLOOR DEMOLITION PLAN					
D104	FOURTH FLOOR DEMOLITION PLAN					
D105	FIFTH FLOOR DEMOLITION PLAN					
D106	ROOF DEMOLITION PLAN					
D300	EXTERIOR ELEVATION DEMOLITION					
D301	EXTERIOR ELEVATION DEMOLITION					
A100	BASEMENT AND GARAGE FLOOR PLAN					
A101	OVERALL FIRST FLOOR PLAN					
A102	OVERALL SECOND FLOOR PLAN					
A103	OVERALL THRID FLOOR PLAN					
A104	OVERALL FOURTH FLOOR PLAN					
A105	OVERALL ROOF PLAN (NEW) 4TH FLOOR MCINTYRE					
A106	McINTYRE ROOF PLAN					
A107	NOT USED					
A250	FIRST FLOOR REFLECTED CEILING PLAN - EXISTING BUILDING					
A251	NOT USED					
A300	NOT USED					
A301	NOT USED					
A302	NOT USED					
A303	EXTERIOR ELEVATIONS					
A304	EXTERIOR ELEVATIONS					
A305	EXTERIOR ELEVATIONS					
A306	EXTERIOR PERSPECTIVES					
	L					

SHEET NO.	SHEET NAME				
A307	EXTERIOR PERSPECTIVES				
A308	EXTERIOR PERSPECTIVES				
A309	EXTERIOR PERSPECTIVES				
A310	NOT USED				
A311	EXTERIOR PERSPECTIVES				
A312	NOT USED				
A401	NOT USED				
A402	NOT USED				

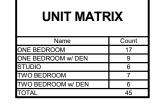

EXISTING BUILDING							
LEVEL	AREA 11,341 SF						
PARKING							
LEVEL 1 (A)	31,568 SF						
LEVEL 2	13,250 SF						
LEVEL 3	13,250 SF						
LEVEL 4	13,250 SF						
TOTAL	82,659 SF						

NEW BUILDING							
LEVEL	AREA						
PARKING	33,061 SF						
LEVEL 1 (B)	6,721 SF						
LEVEL 1 (A)	8,668 SF						
LEVEL 2	18,637 SF						
LEVEL 3	17,514 SF						
LEVEL 4	7,206 SF						
TOTAL	01 907 SE						

FIRE EXITINGUISHER
FIRE EXT. CABINET
FIRE HOSE CABINET
FINISH
FLOOR
FACE OF CONCRETE
FACE OF MASONRY
FACE OF STUD
FIREPROOF
FRAME
FOOT OR FEET
FOOTING

GAUGE GALVANIZED GRAB BAR GYPSUM WALL BOARD


HOSE BIB
HARDWOOD
HARDWARE
HEARING IMPAIRED
HEIGHT
HOLLOW METAL
HORIZONTAL
HOT WATER
HEATING, VENTING & A.C.

INSIDE DIAMETER (DIM)

INFO INSUL INT JAN

LAB LAV LB(S) LGMF

NIC NTS

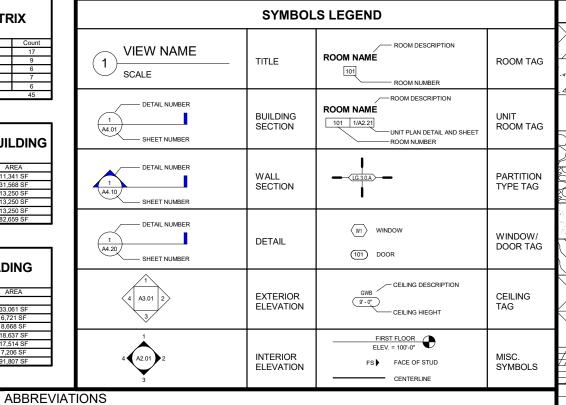

1 A4.01 SHEET NUMBER	BUILDING SECTION		-UNIT PLAN DETAIL AND SHEE	UNIT ROOM TAG	SAND/GROUT
SHEET NUMBER			-ROOM NUMBER		GRAVEL
DETAIL NUMBER  1 A4.10 SHEET NUMBER	WALL SECTION	LG.30A	-	PARTITION TYPE TAG	COMPACTED FILL
DETAIL NUMBER	DETAIL	⟨W1⟩ WINI	DOW	WINDOW/ DOOR TAG	STONE
A4.20 SHEET NUMBER		(101) DOC	DR	BOOK TAO	WOOD FINISH
4 A3.01 2	EXTERIOR ELEVATION	GWB	- CEILING DESCRIPTION	CEILING TAG	WOOD DIMENSIONAL LUMBER
1		FIRS	ST FLOOR		WOOD BLOCKING/SHIM
4 A2.01 2	INTERIOR ELEVATION	ELEV. FS <b>)</b>	FACE OF STUD	MISC. SYMBOLS	PLYWOOD
TIONS					INSULATION RIGID
INSULATION PL	AM PLASTIC LA BG PLUMBING F POUNDS PE	EERED BUILDING MINATE ER SQUARE FOOT ER SQUARE INCH	ST         STREE           STA         STATIO           STC         SOUNE           STD         STAND           STL         STEEL           STOR         STORA	N ) TRANSMISSION CLASS ARD	INSULATION BLOWN IN
LABORATORY R/ LAVATORY R. POUND(S) RE LIGHT GAUGE METAL FRAMING RE	D. ROOF DRAI	E	STRUC. STRUC	TURAL F CURB	INSULATION BATT
RE MACHINE RE MATERIAL RE MAXIMUM R. MECHANICAL RE METAL R. MANUFACTURER R.	EQ'D REQUIRED ES RESILIENT EV REVISION F. RESILIENT I M ROOM	FLOORING	THK THICK ( T.O.B. TOP OF T.O.T. TOP OF	(THICKNESS) F BEAM F TRUSS FORMER SION F WALL	MASONRY BRICK
	C. SOLID COR CHED SCHEDULE ECT SECTION	Ē		RWRITER'S LABORATORY S NOTED OTHERWISE	MASONRY BLOCK
SI   NOT IN CONTRACT	HWR SHOWER HT SHEET M SIMILAR PEC SPECIFICAT Q SQUARE		VERT VERTIC VEST VESTIB W.C. WATER	CLOSET	EIFS
OUTSIDE DIAMETER SF OPPOSITE S.		OOT STEEL	WD WOOD WO WITHO	UT	STEEL

ANCHOR BOLT
ACOUSTICAL CELING TILE
ABOVE FINISH ELOOR
ABOVE FINISH GRADE
ASSISTED LIVING
ALUMINUM
ALUMINUM
ALTERNATE
APPROXIMATE
ASPHALT
ALZHEIMER'S

CABINET
CATCH BASIN
CONTROL JOINT
CELLING
CLOSET
CLEAR(ANCE)
CONCRETE MASONRY UNIT
COLUMN
CLEAN OUT
CONTROL POINT

CARPET CERAMIC TILE CENTER COLD WATER

DOUBLE
DEPARTMENT
DRINKING FOUNTAIN
DINKKING FOUNTAIN
DIVISION
DOWN
DOOR OPENING
DRAWING
DOWNSPOUT

ELECTRICAL FLOOR OUTLET EXPANSION JOINT ELECTRICAL ELEVATION EMERGENCY EQUAL EXISTING EXISTING


FIRE ALARM FLOOR DRAIN FOUNDATION

CPT C.T. CTR C.W.


**MATERIAL LEGEND** 

DISTURBED EARTH

CONCRETE

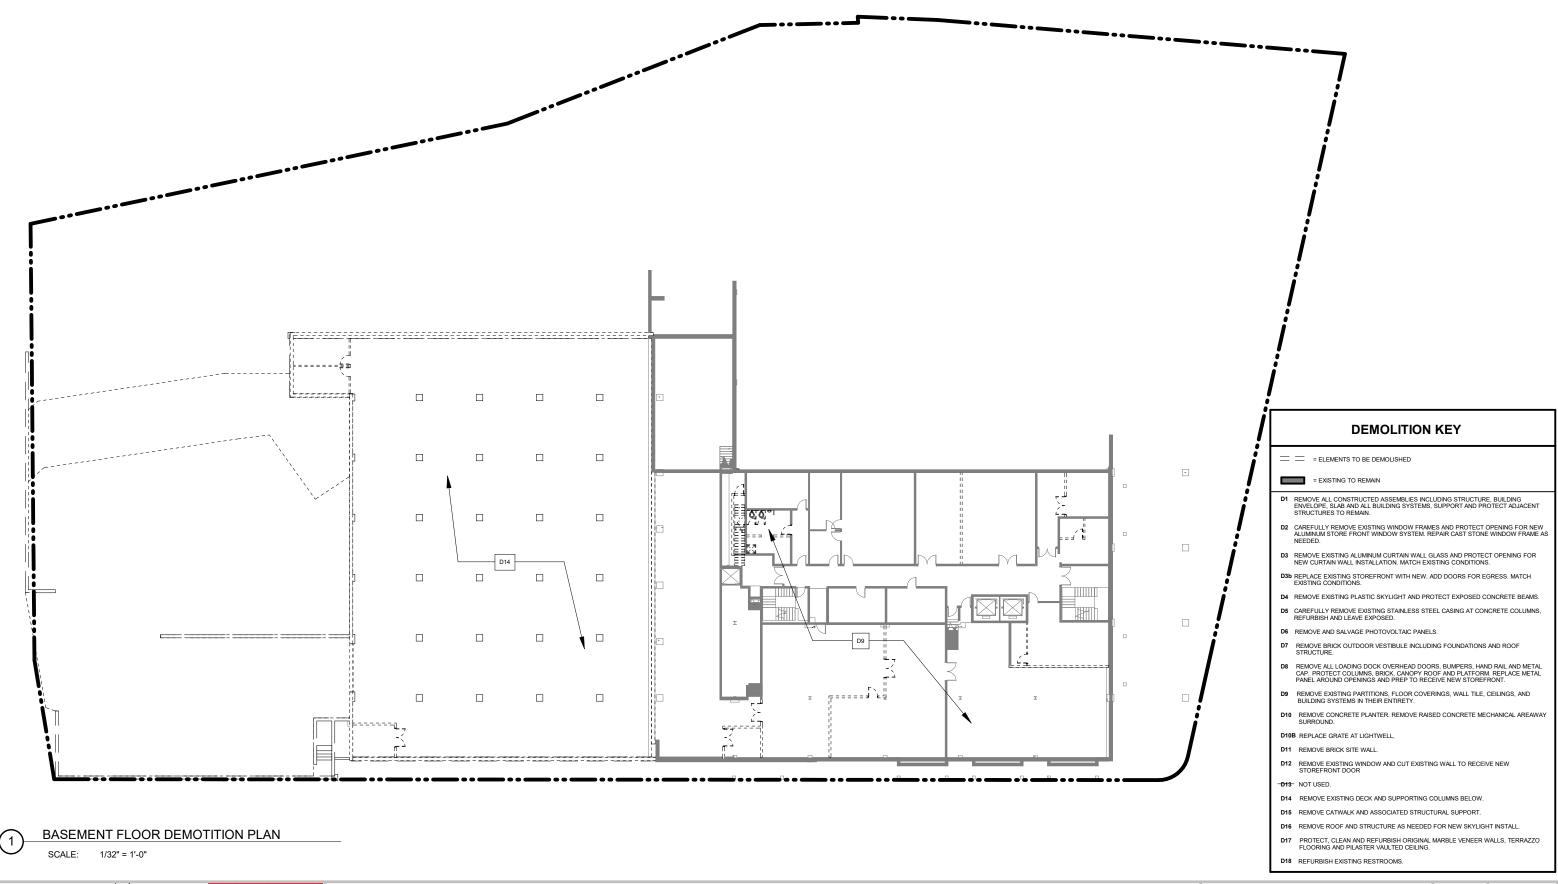




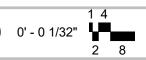






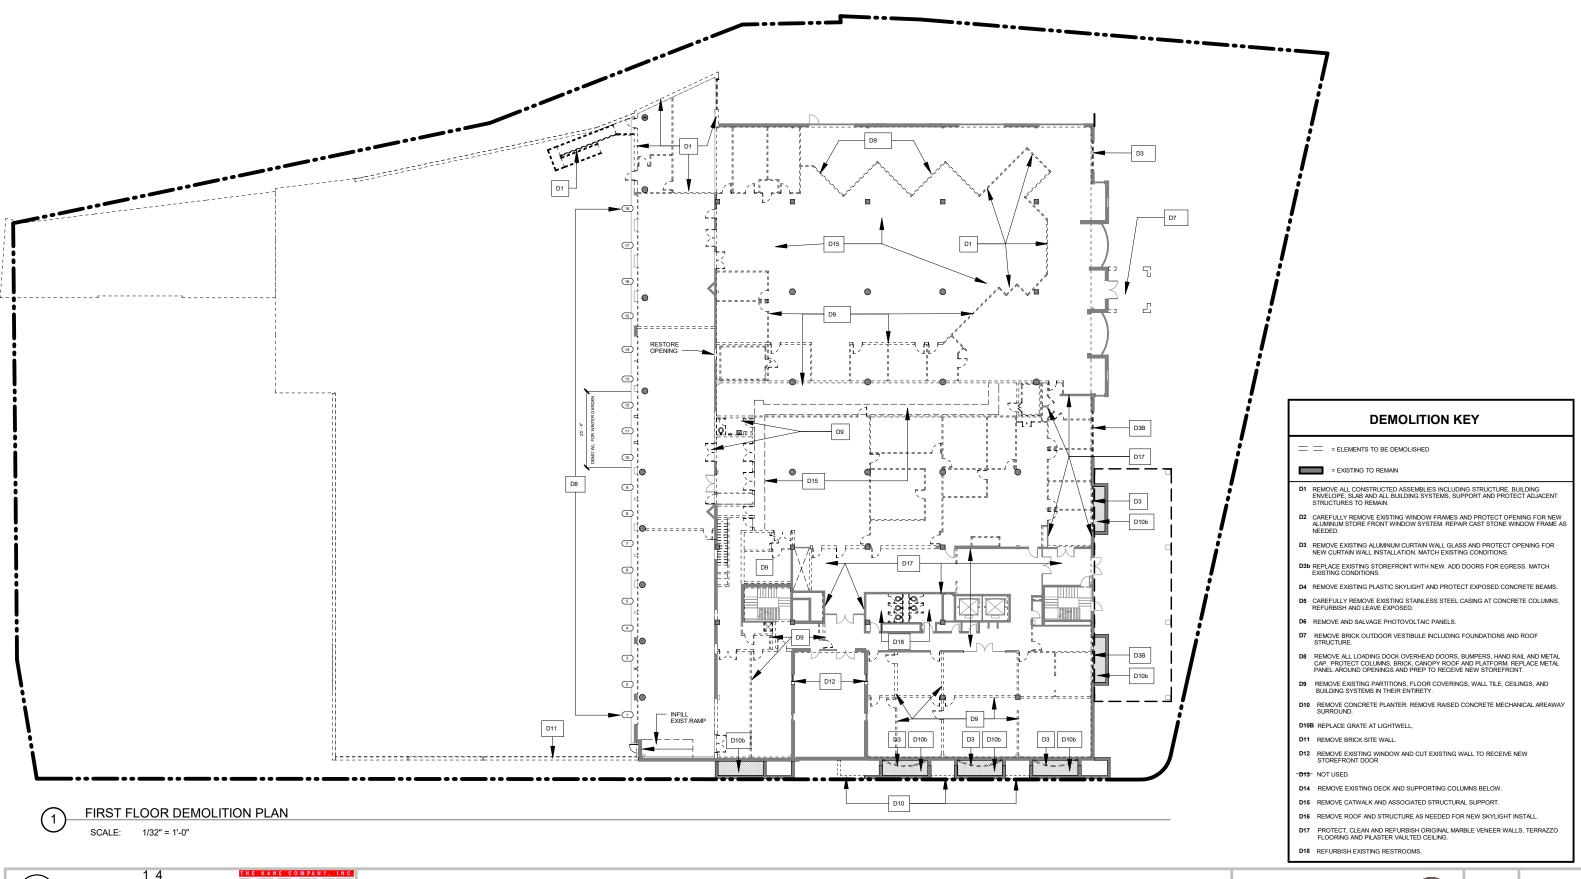




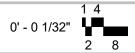







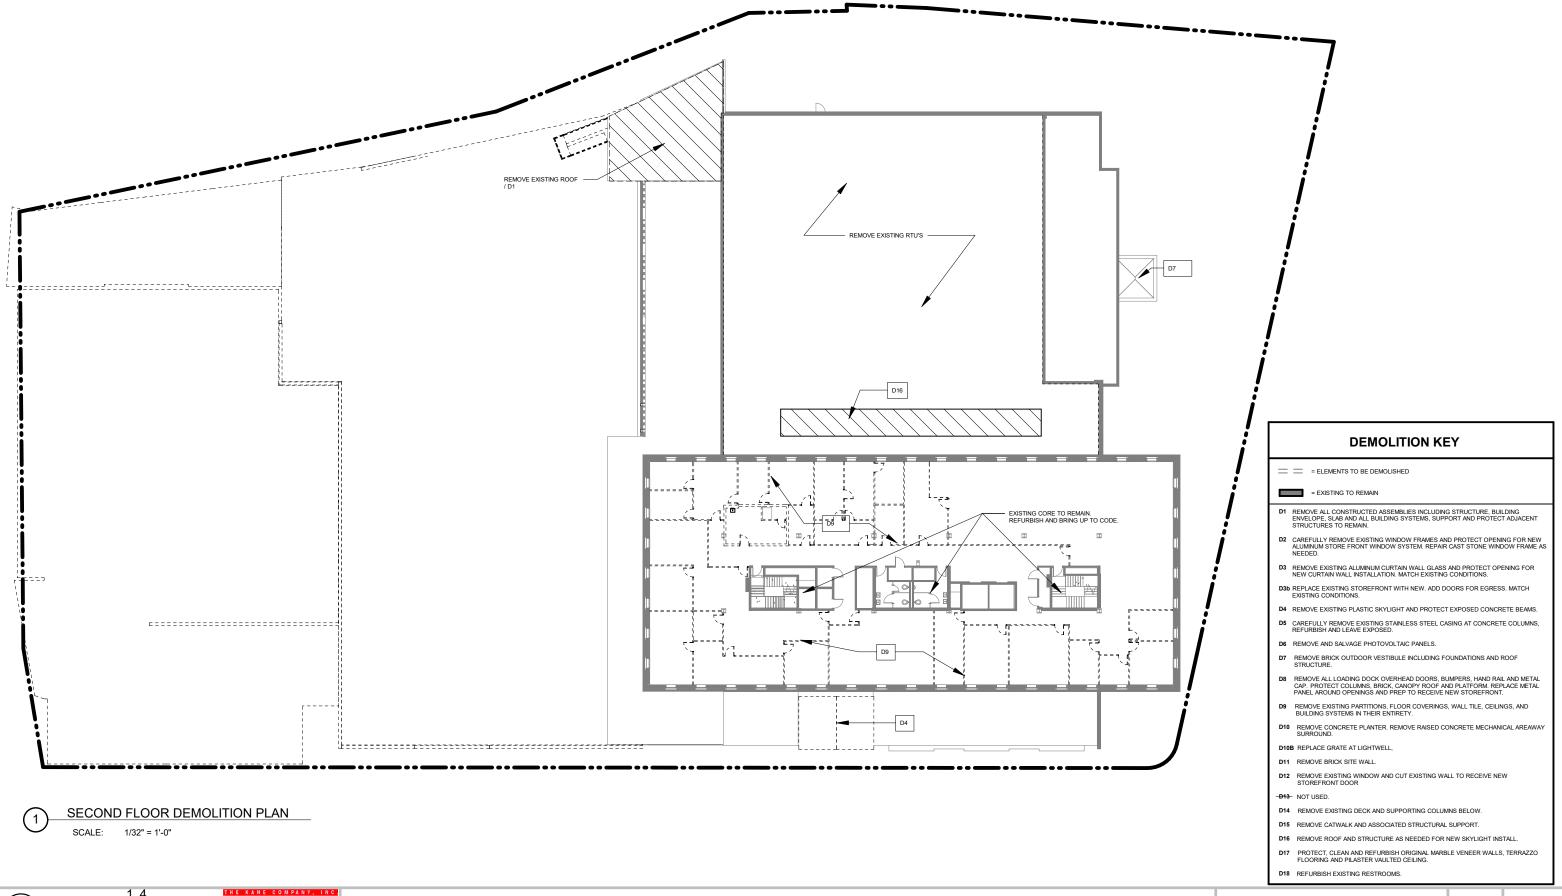















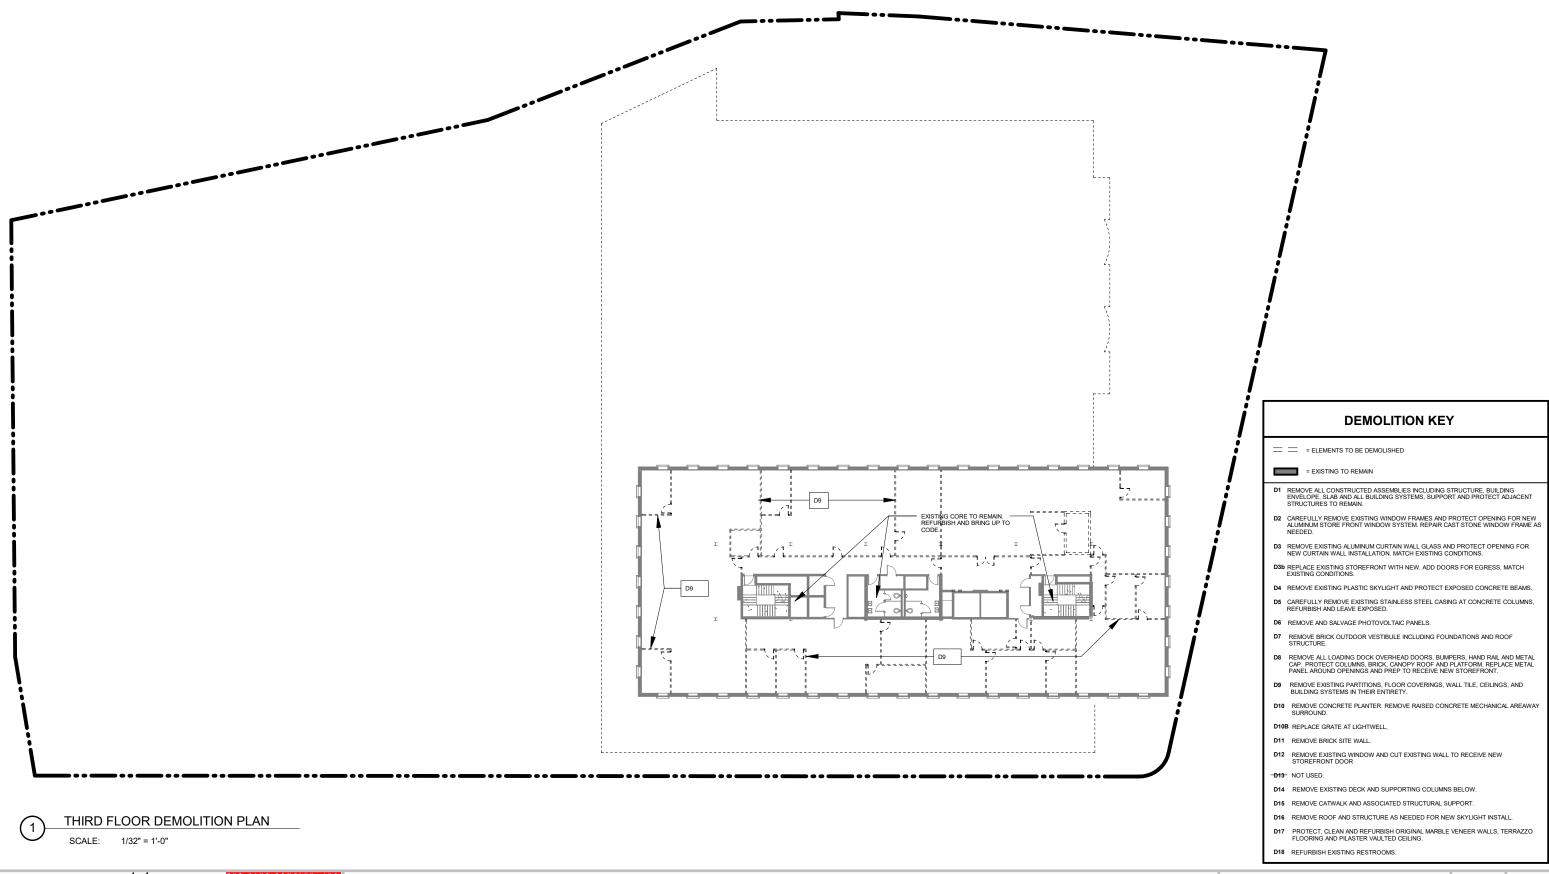




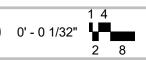







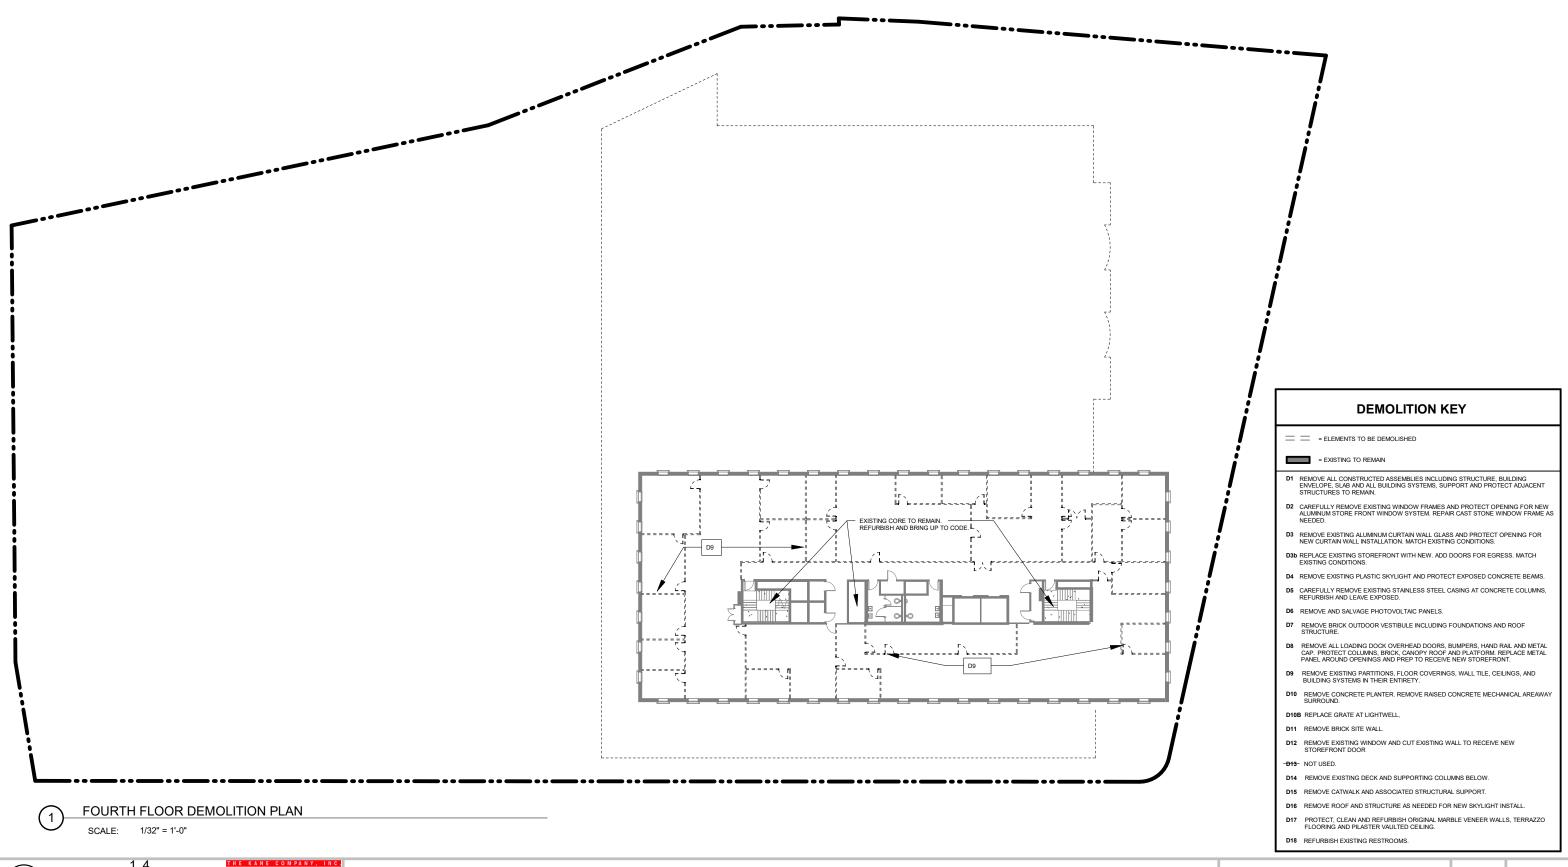












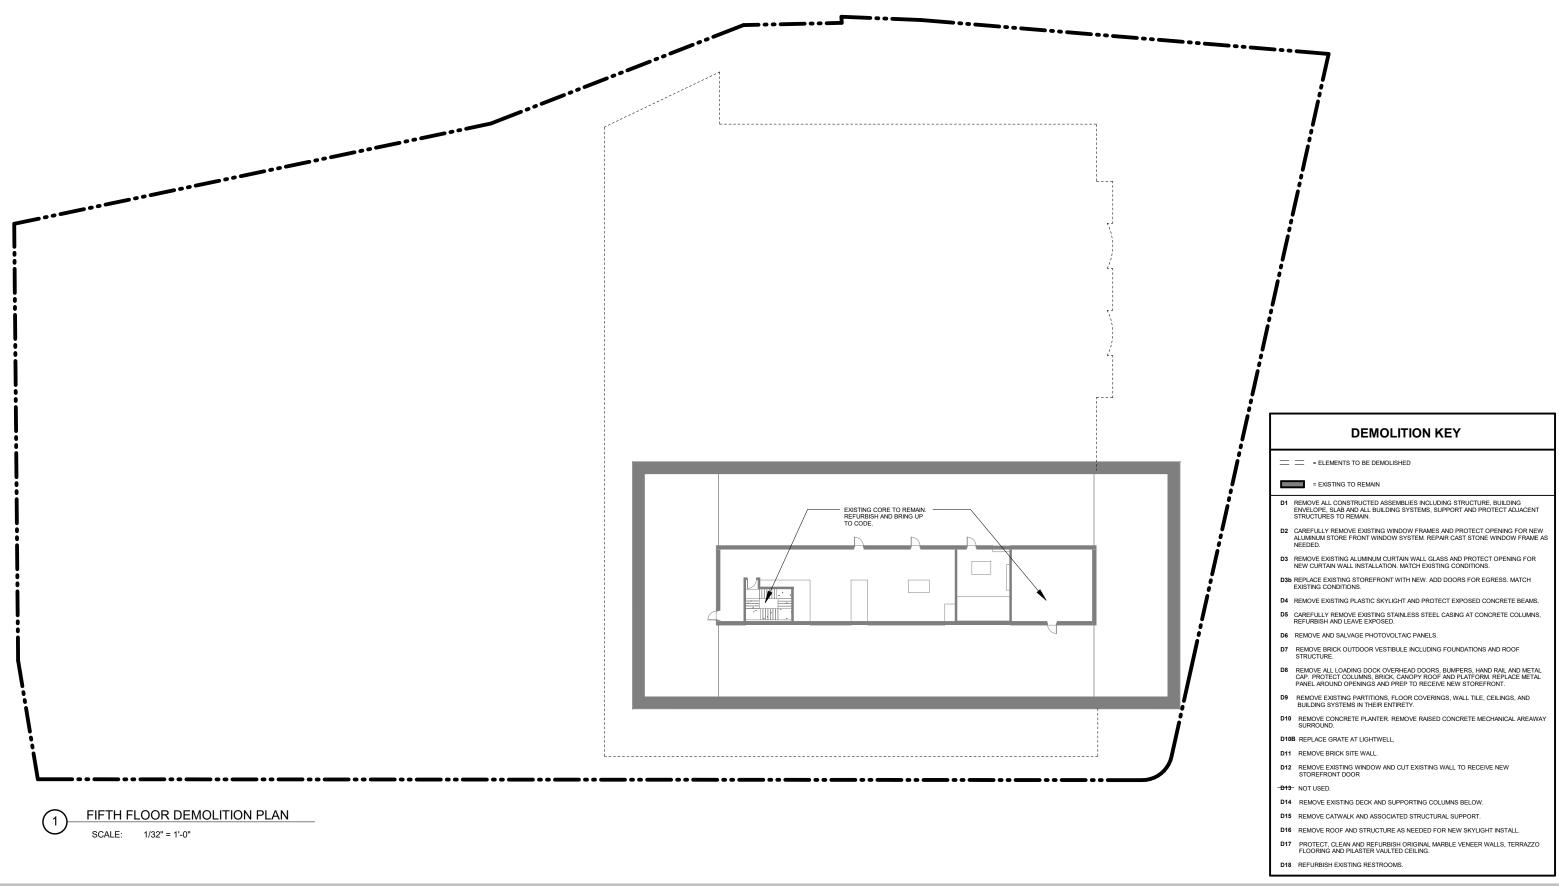














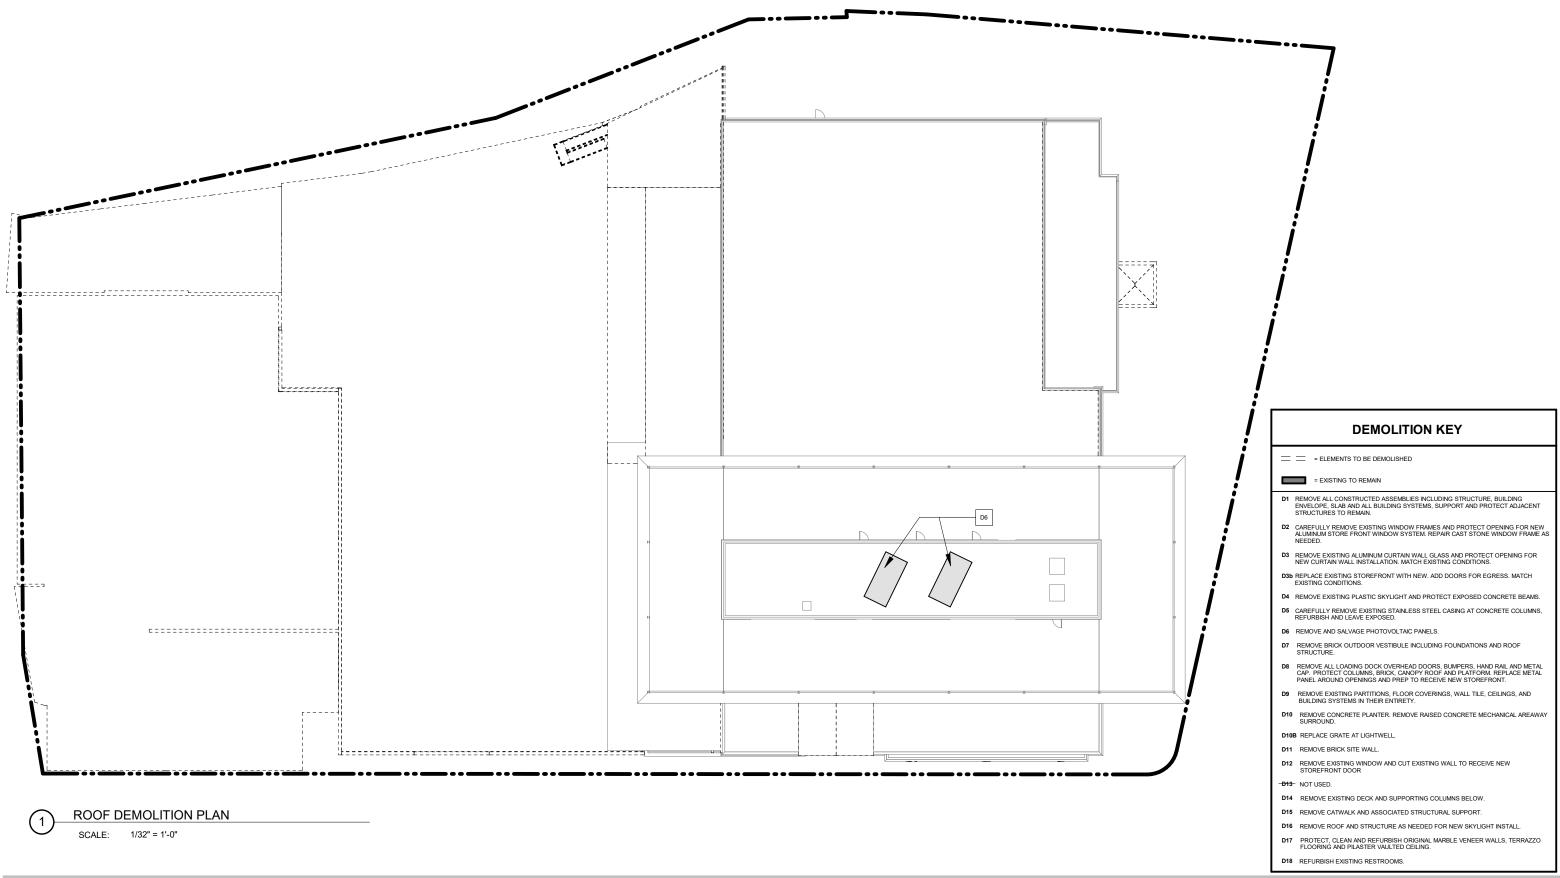












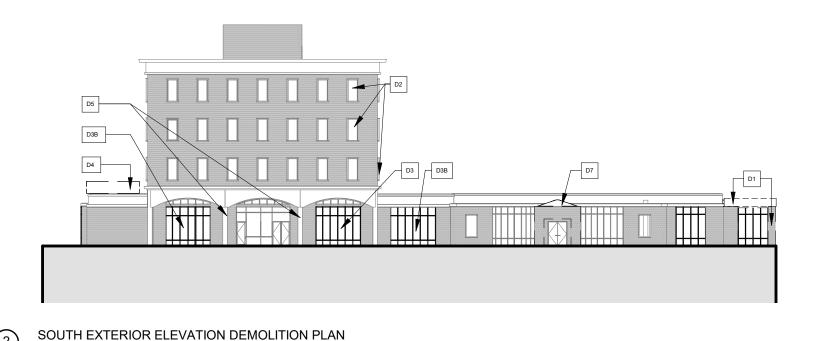


**DEMOLITION KEY** 

= = ELEMENTS TO BE DEMOLISHED

= EXISTING TO REMAIN


- D1 REMOVE ALL CONSTRUCTED ASSEMBLIES INCLUDING STRUCTURE, BUILDING ENVELOPE, SLAB AND ALL BUILDING SYSTEMS, SUPPORT AND PROTECT ADJACENT STRUCTURES TO REMAIN.
- D2 CAREFULLY REMOVE EXISTING WINDOW FRAMES AND PROTECT OPENING FOR NEW ALUMINUM STORE FRONT WINDOW SYSTEM. REPAIR CAST STONE WINDOW FRAME AS NEEDDE.
- D3 REMOVE EXISTING ALUMINUM CURTAIN WALL GLASS AND PROTECT OPENING FOR NEW CURTAIN WALL INSTALLATION. MATCH EXISTING CONDITIONS.
- **D3b** REPLACE EXISTING STOREFRONT WITH NEW. ADD DOORS FOR EGRESS. MATCH EXISTING CONDITIONS.
- ${\bf D4}$   $\,$  REMOVE EXISTING PLASTIC SKYLIGHT AND PROTECT EXPOSED CONCRETE BEAMS.
- D5 CAREFULLY REMOVE EXISTING STAINLESS STEEL CASING AT CONCRETE COLUMNS, REFURBISH AND LEAVE EXPOSED.
- D6 REMOVE AND SALVAGE PHOTOVOLTAIC PANELS.
- **D7** REMOVE BRICK OUTDOOR VESTIBULE INCLUDING FOUNDATIONS AND ROOF STRUCTURE.
- D8 REMOVE ALL LOADING DOCK OVERHEAD DOORS, BUMPERS, HAND RAIL AND METAL CAP. PROTECT COLUMNS, BRICK, CANOPY ROOF AND PLATFORM. REPLACE METAL PANEL AROUND OPENINGS AND PREP TO RECEIVE NEW STOREFRONT.
- D9 REMOVE EXISTING PARTITIONS, FLOOR COVERINGS, WALL TILE, CEILINGS, AND BUILDING SYSTEMS IN THEIR ENTIRETY.
- **D10** REMOVE CONCRETE PLANTER. REMOVE RAISED CONCRETE MECHANICAL AREAWAY SURROUND.
- D10B REPLACE GRATE AT LIGHTWELL,
- D11 REMOVE BRICK SITE WALL.
- D12 REMOVE EXISTING WINDOW AND CUT EXISTING WALL TO RECEIVE NEW STOREFRONT DOOR
- D14 REMOVE EXISTING DECK AND SUPPORTING COLUMNS BELOW.
- D15 REMOVE CATWALK AND ASSOCIATED STRUCTURAL SUPPORT.
- D16 REMOVE ROOF AND STRUCTURE AS NEEDED FOR NEW SKYLIGHT INSTALL.
- D17 PROTECT, CLEAN AND REFURBISH ORIGINAL MARBLE VENEER WALLS, TERRAZZO FLOORING AND PILASTER VAULTED CEILING.
- D18 REFURBISH EXISTING RESTROOMS.

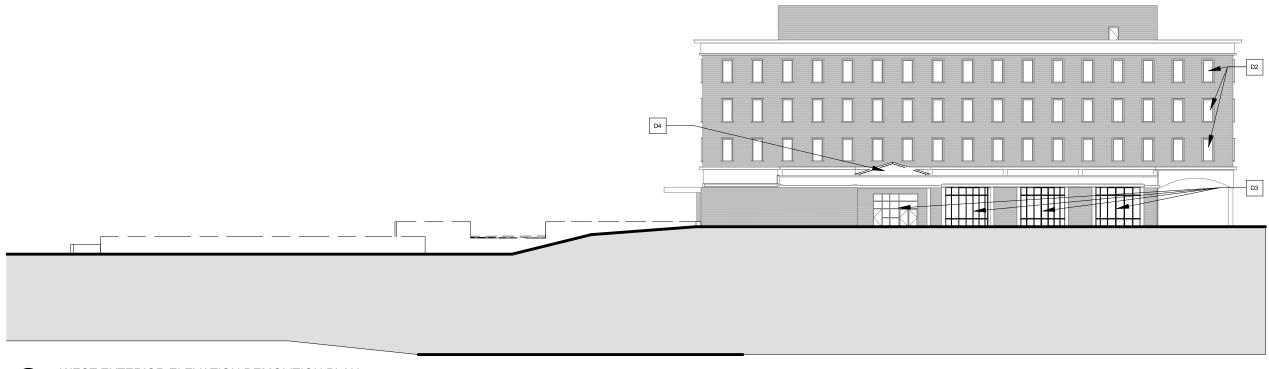


WEST EXTERIOR ELEVATION DEMOLITION PLAN

SCALE: 1/32" = 1'-0"

1/32" = 1'-0"

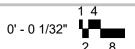




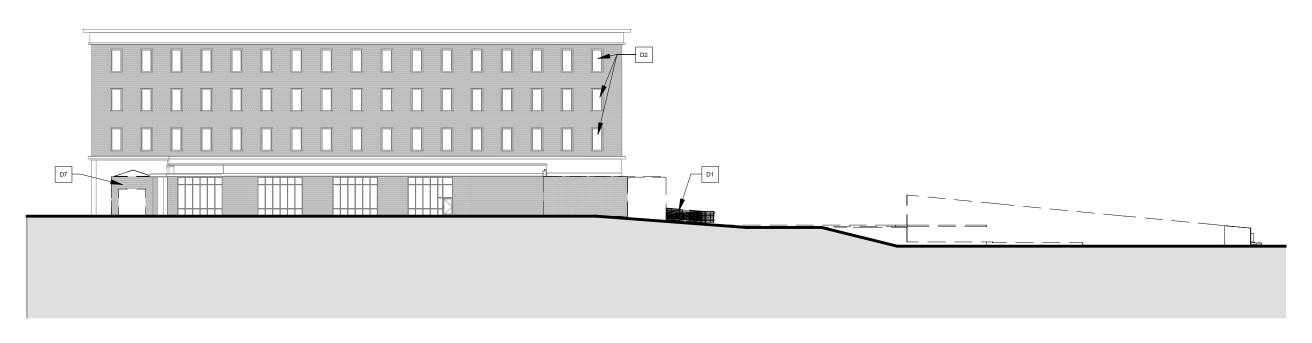

## EAST EXTERIOR ELEVATION DEMOLITION PLAN

SCALE: 1/32" = 1'-0"

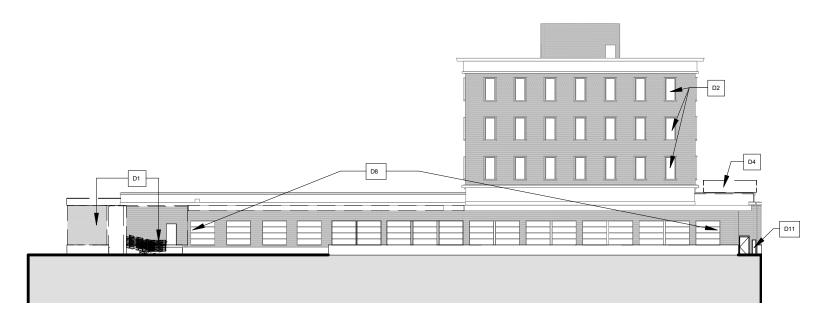

## NORTH EXTERIOR ELEVATION DEMOLITION PLAN

SCALE: 1/32" = 1'-0"

#### **DEMOLITION KEY**

= = ELEMENTS TO BE DEMOLISHED

= EXISTING TO REMAIN

D1 REMOVE ALL CONSTRUCTED ASSEMBLIES INCLUDING STRUCTURE, BUILDING ENVELOPE, SLAB AND ALL BUILDING SYSTEMS, SUPPORT AND PROTECT ADJACENT STRUCTURES TO REMAIN.

D2 CAREFULLY REMOVE EXISTING WINDOW FRAMES AND PROTECT OPENING FOR NEW ALUMINUM STORE FRONT WINDOW SYSTEM. REPAIR CAST STONE WINDOW FRAME AS NEEDED.

D3 REMOVE EXISTING ALUMINUM CURTAIN WALL GLASS AND PROTECT OPENING FOR NEW CURTAIN WALL INSTALLATION. MATCH EXISTING CONDITIONS.

D3b REPLACE EXISTING STOREFRONT WITH NEW. ADD DOORS FOR EGRESS. MATCH EXISTING CONDITIONS.

**D4** REMOVE EXISTING PLASTIC SKYLIGHT AND PROTECT EXPOSED CONCRETE BEAMS.

D5 CAREFULLY REMOVE EXISTING STAINLESS STEEL CASING AT CONCRETE COLUMNS, REFURBISH AND LEAVE EXPOSED.

D6 REMOVE AND SALVAGE PHOTOVOLTAIC PANELS.

D7 REMOVE BRICK OUTDOOR VESTIBULE INCLUDING FOUNDATIONS AND ROOF STRUCTURE.

D8 REMOVE ALL LOADING DOCK OVERHEAD DOORS, BUMPERS, HAND RAIL AND METAL CAP. PROTECT COLUMNS, BRICK, CANOPY ROOF AND PLATFORM. REPLACE METAL PANEL AROUND OPENINGS AND PREP TO RECEIVE NEW STOREFRONT.

D9 REMOVE EXISTING PARTITIONS, FLOOR COVERINGS, WALL TILE, CEILINGS, AND BUILDING SYSTEMS IN THEIR ENTIRETY.

D10 REMOVE CONCRETE PLANTER. REMOVE RAISED CONCRETE MECHANICAL AREAWAY SURROUND.

D10B REPLACE GRATE AT LIGHTWELL,

D11 REMOVE BRICK SITE WALL.

D12 REMOVE EXISTING WINDOW AND CUT EXISTING WALL TO RECEIVE NEW STOREFRONT DOOR

D14 REMOVE EXISTING DECK AND SUPPORTING COLUMNS BELOW.


D15 REMOVE CATWALK AND ASSOCIATED STRUCTURAL SUPPORT.

D16 REMOVE ROOF AND STRUCTURE AS NEEDED FOR NEW SKYLIGHT INSTALL.

D17 PROTECT, CLEAN AND REFURBISH ORIGINAL MARBLE VENEER WALLS, TERRAZZO FLOORING AND PILASTER VAULTED CEILING.

D18 REFURBISH EXISTING RESTROOMS.



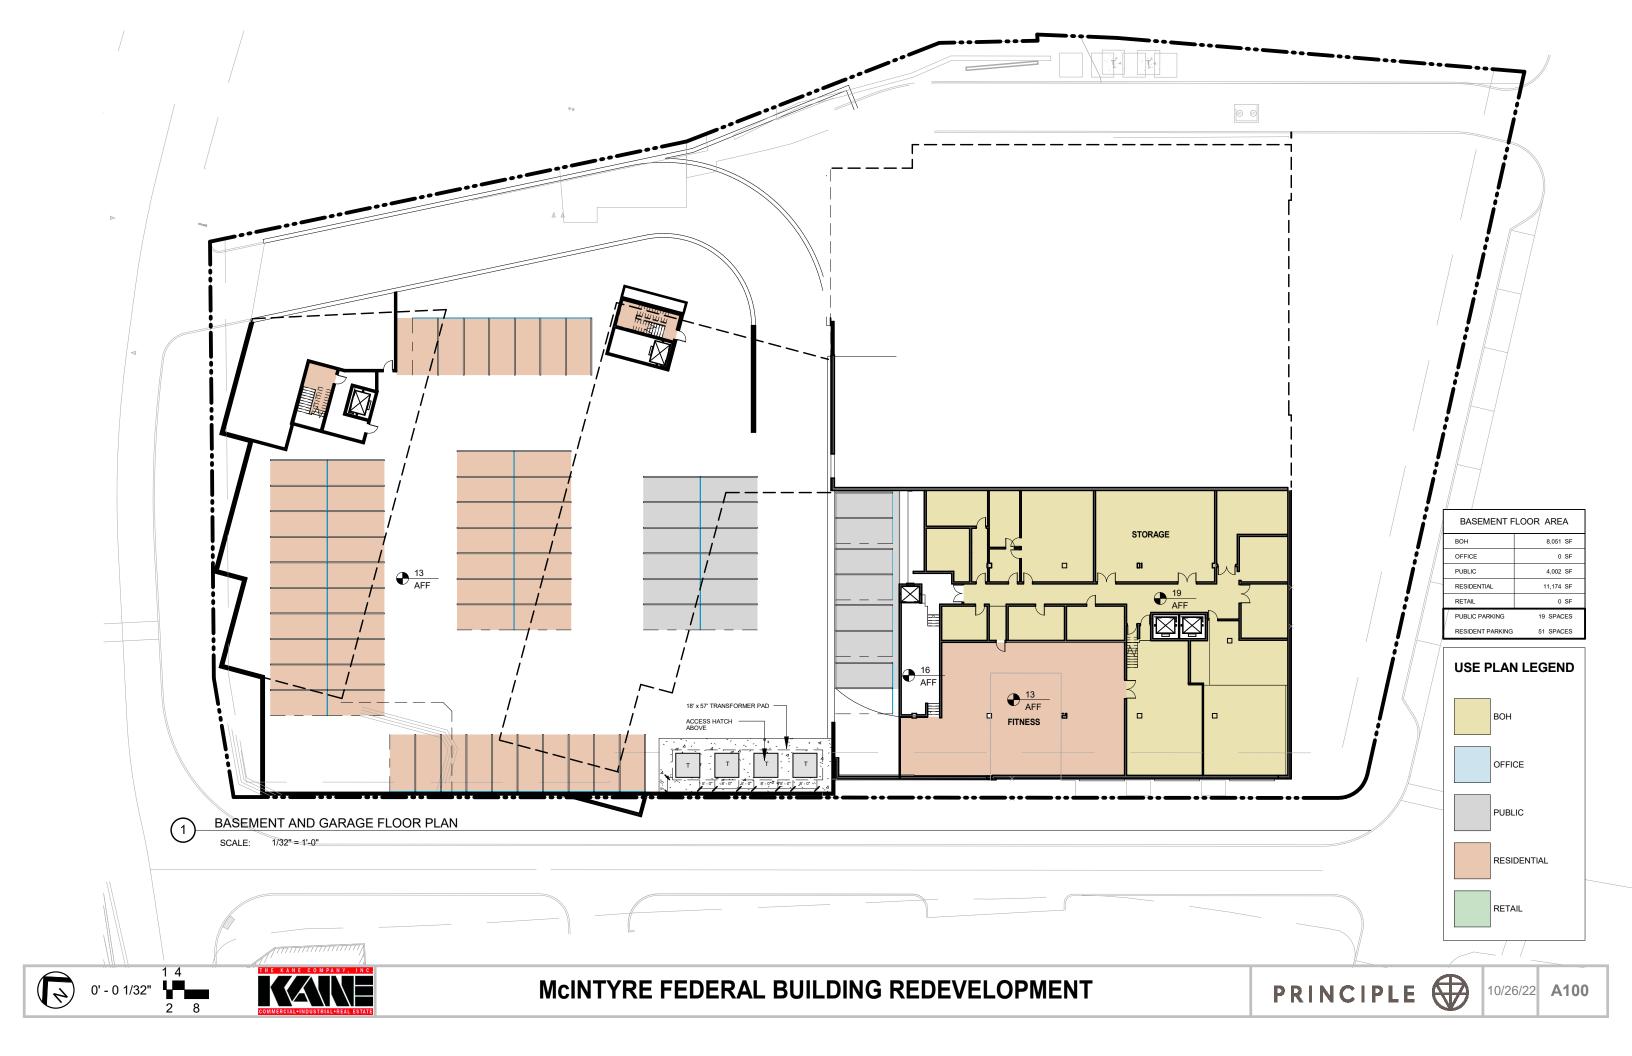














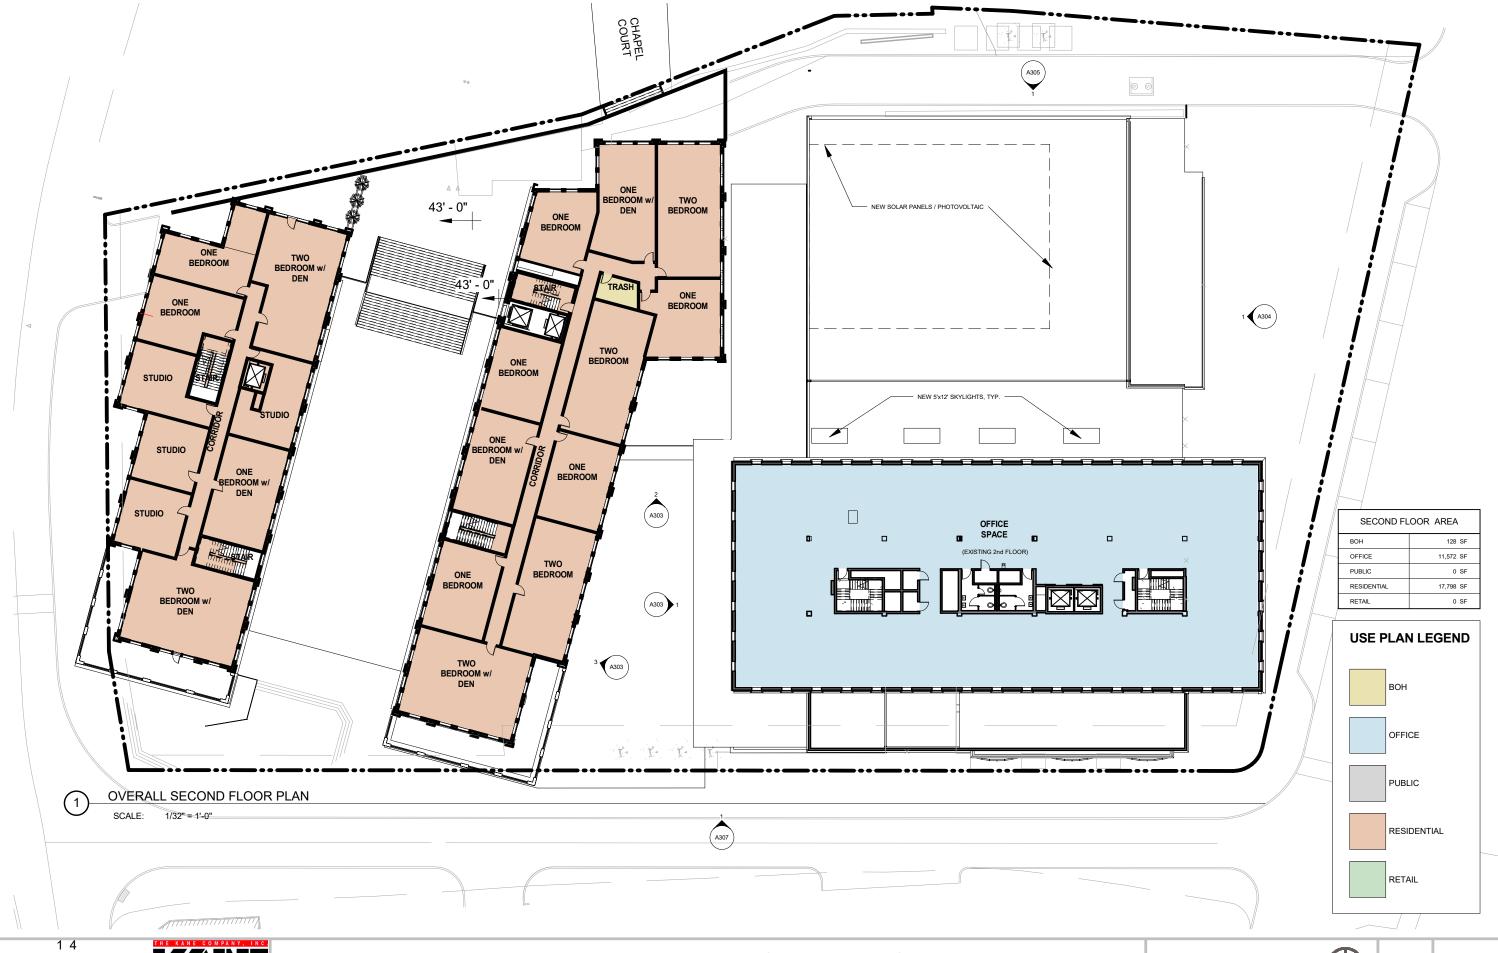



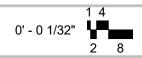




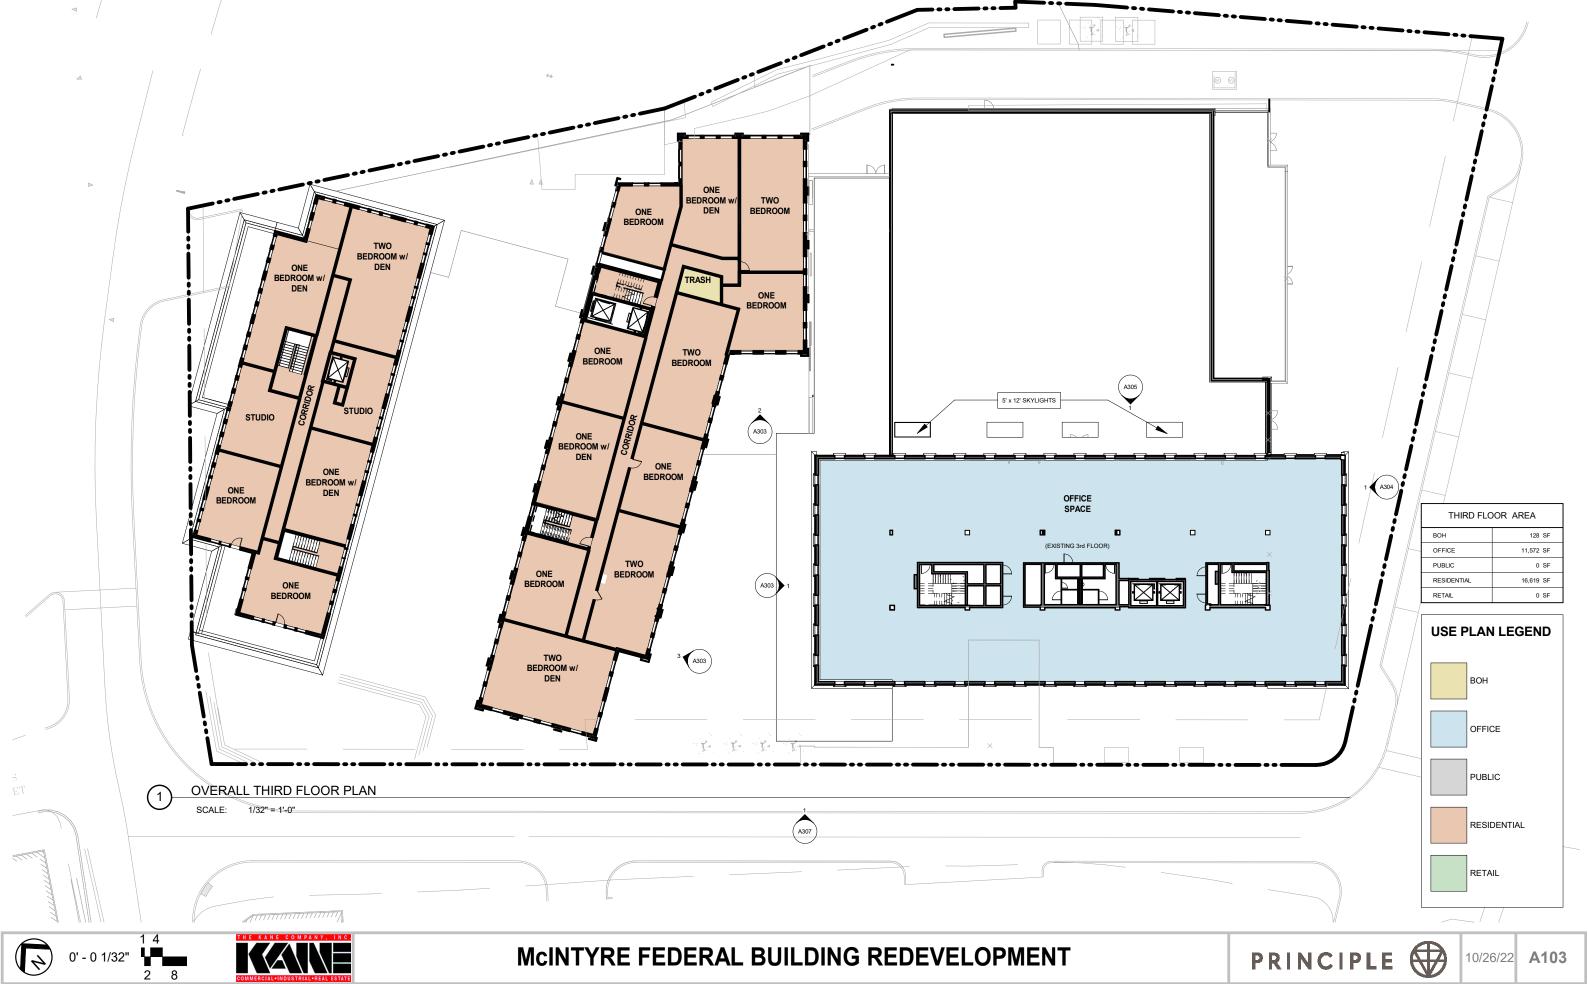









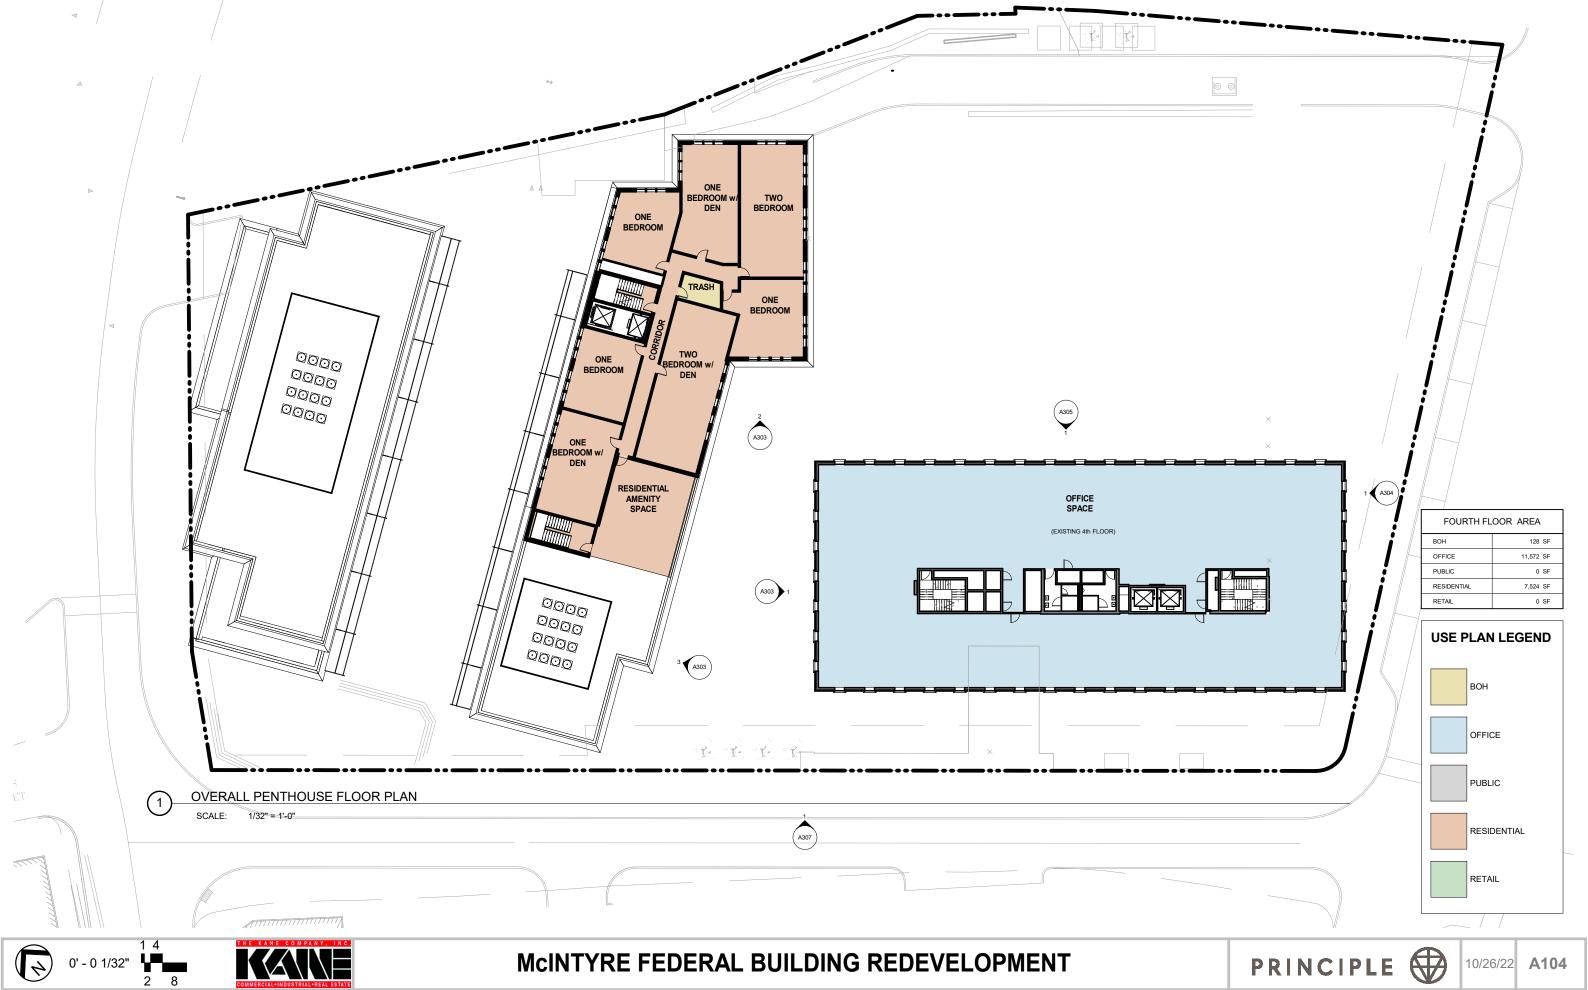




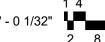




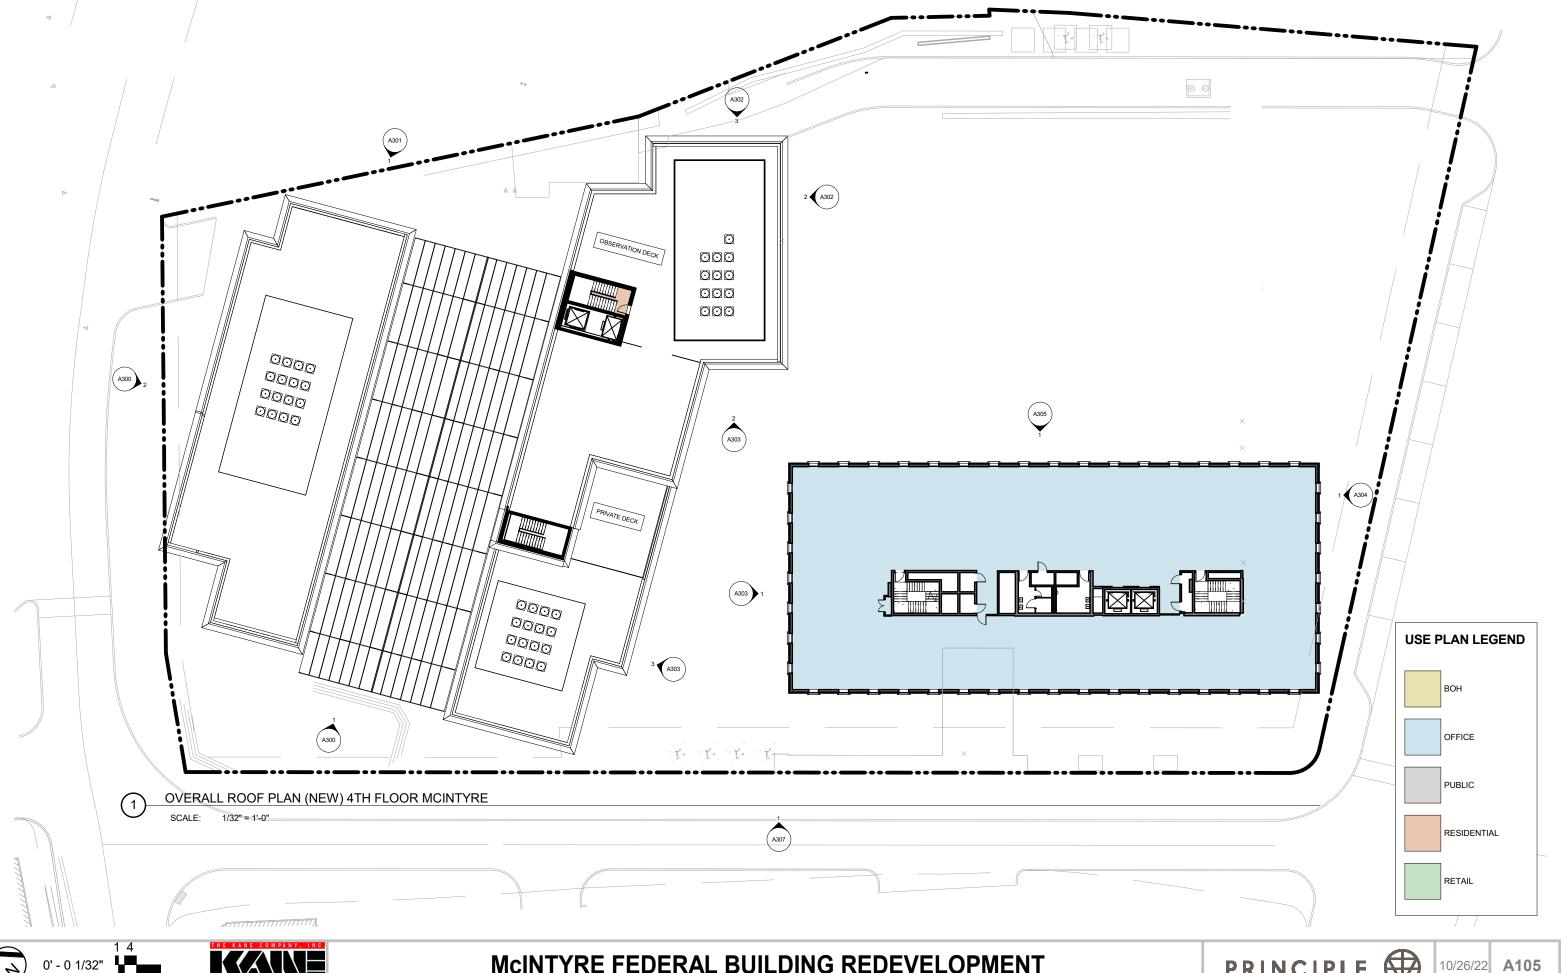



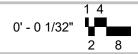



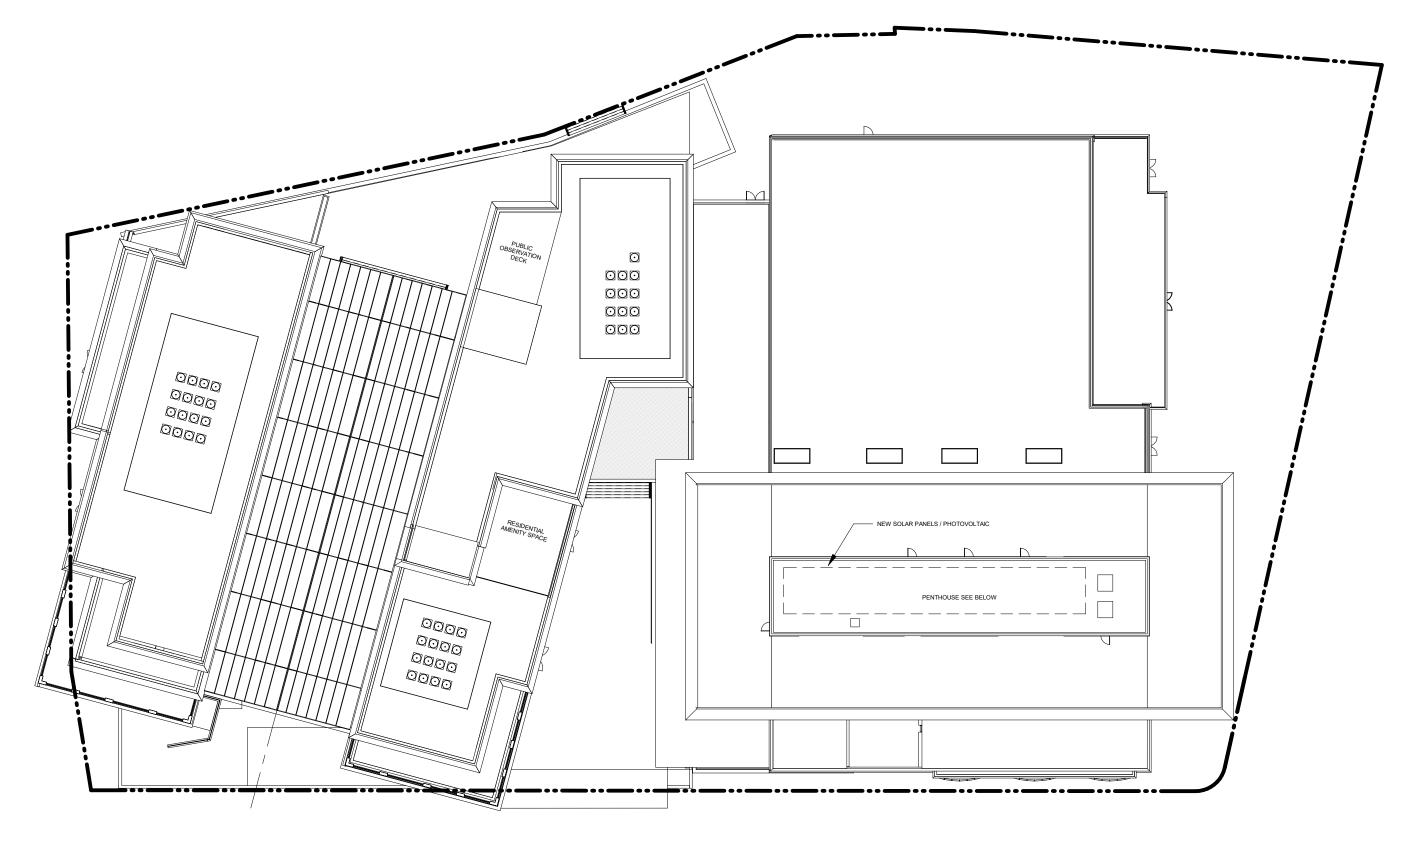











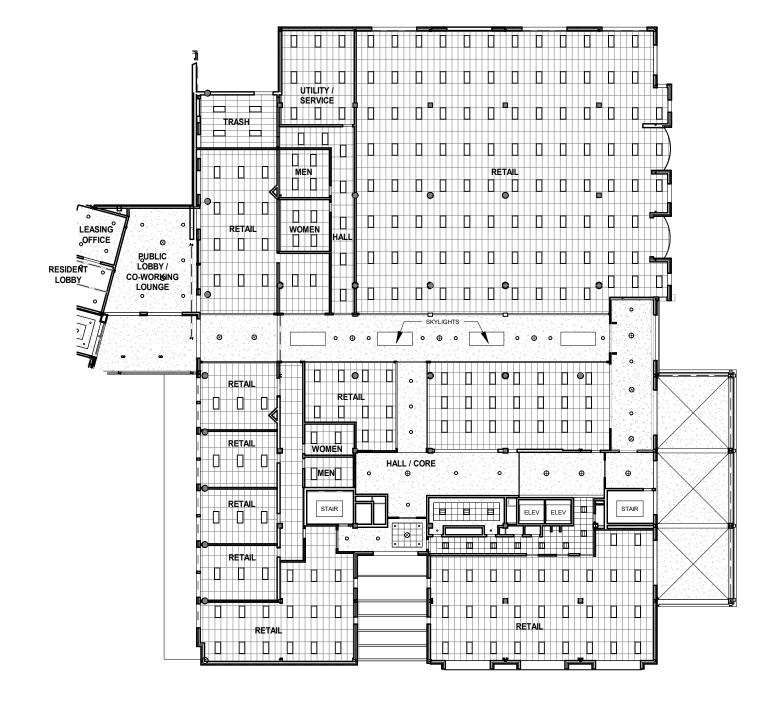


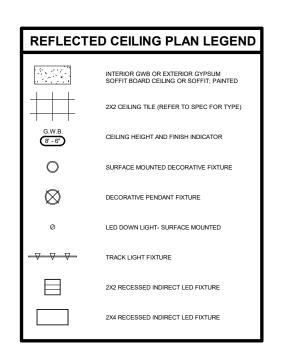


FIRST FLOOR REFLECTED CEILING PLAN - EXISTING BUILDING

SCALE: 1/32" = 1'-0"



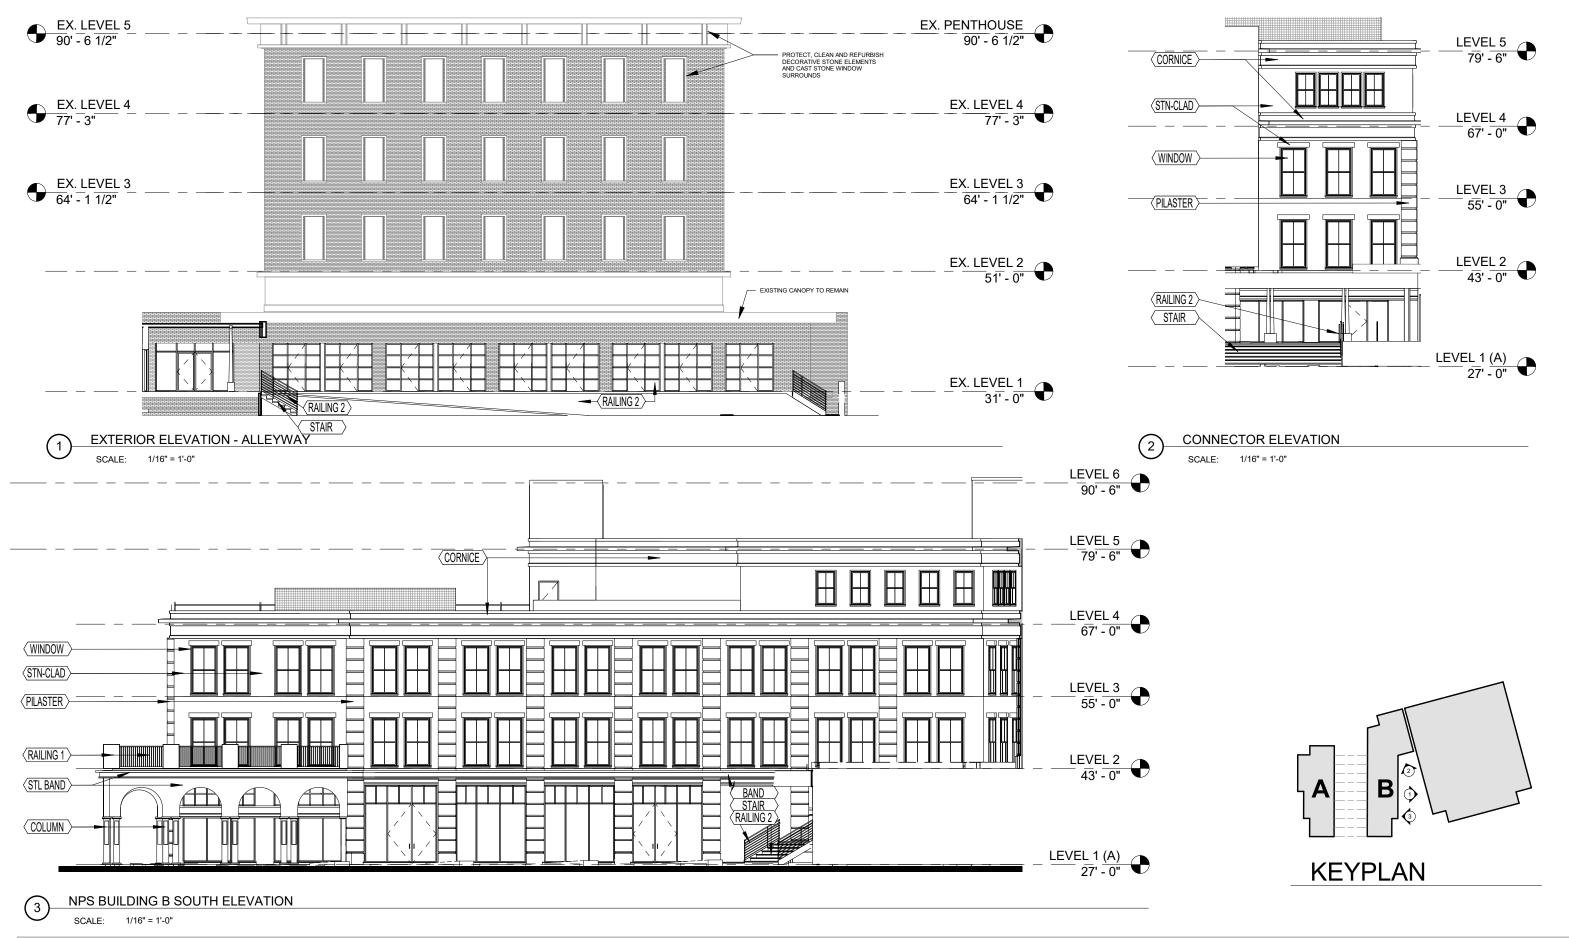



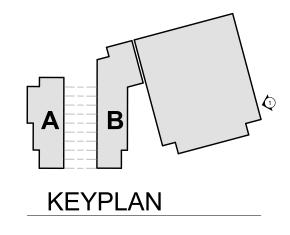




**EXTERIOR ELEVATION - DANIEL STREET** 

1/16" = 1'-0"



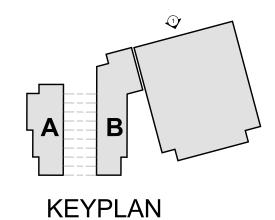












PRINCIPLE

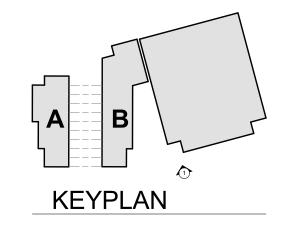







# PENHALLOW STREET ELEVATION

SCALE: 1/32" = 1'-0"

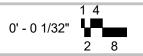



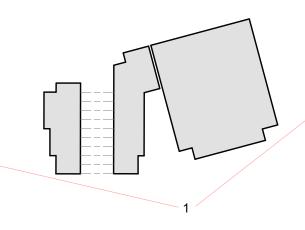



# **KEYPLAN**



OVERALL EXTERIOR PERSPECTIVE




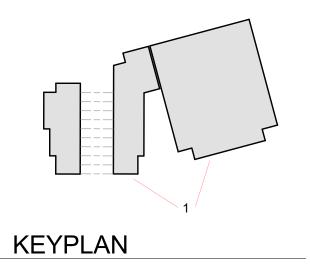


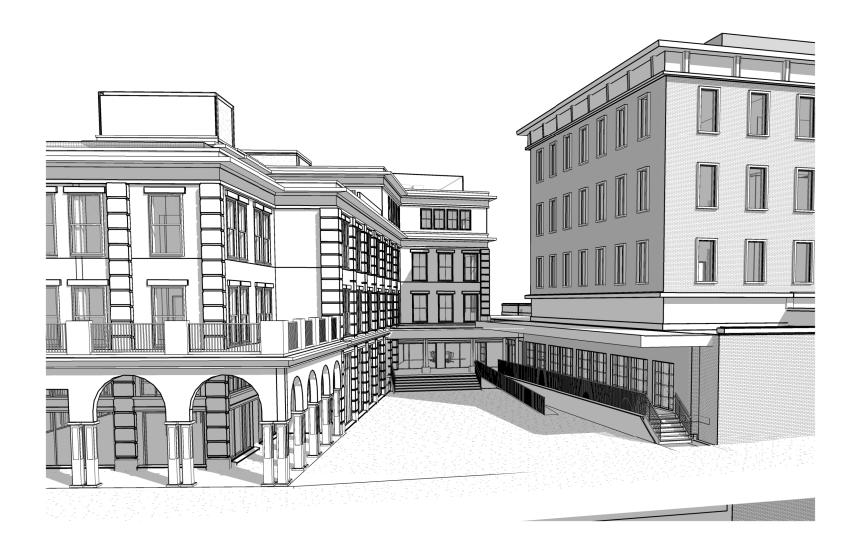

EXTERIOR PERSPECTIVE



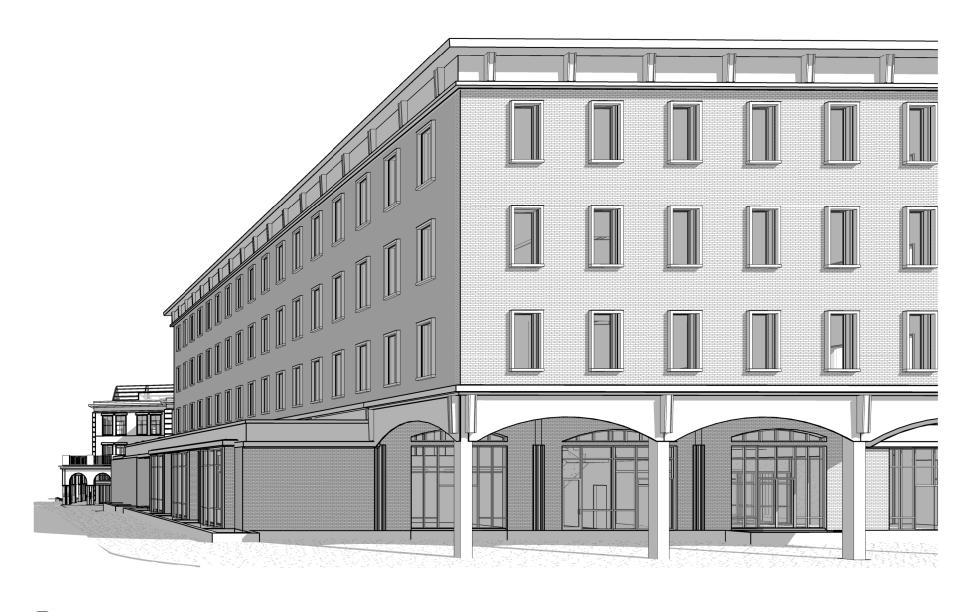

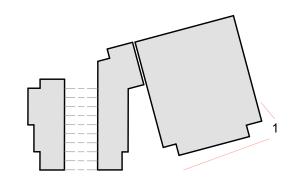

EXTERIOR PERSPECTIVE

**KEYPLAN** 

